
PROPOSED FOR:

HCMED ADMIN FACILITY

HILLSIDE ROAD HAPPY CAMP, SISKIYOU, CA 96039

PROJECT NUMBER: #22-6373

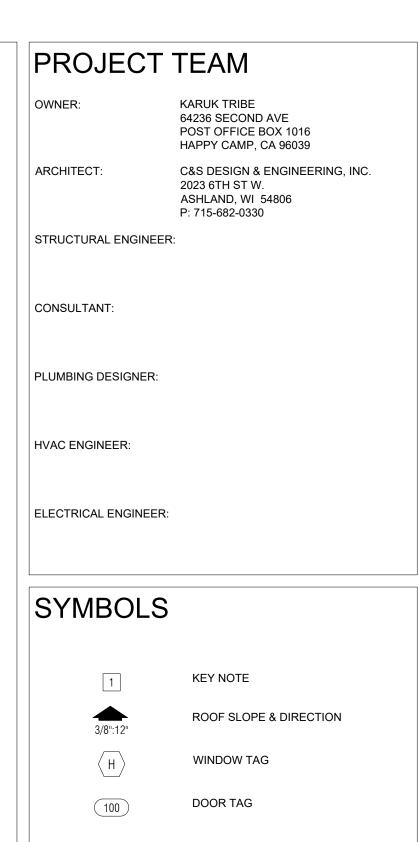

SLOPE OF SLAB

INTERIOR ELEVATION TAG

STEP/ELEVATION CHANGE

WALL TYPE (SEE PLAN OR LEGEND FOR ADD. INFO)

ELEVATION MARKER

BUILDING ELEVATION

BUILDING SECTION

DETAIL/ENLARGED PLAN

CALLOUT

CONCRETE MASONRY UNIT

CONTINUOUS

CMU

FINISH FLOOR ELEVATION

FINISH GRADE

FINISH SURFACE

DETAIL CALLOUT

PROJECT DATA PROJECT NAME: HC MED ADMIN FACILITY

PROJECT ADDRESS: 64236 SECOND AVENUE PO BOX 1016, HAPPY CAMP, CA 96039 KARUK TRIBE OWNER:

GENERAL NOTES

APPROVED PLANS AT THE JOB SITE AT ALL TIMES. 2. A PRE-CONSTRUCTION CONFERENCE MAY BE HELD WITH THE CONTRACTORS BEFORE ANY WORK COMMENCES AS DIRECTED BY

3. ALL WORK IS TO BE PERFORMED IN ACCORDANCE WITH STATE BUILDING, PLUMBING, ELECTRICAL, AND HVAC CODE CURRENTLY IN EFFECT. 4. ALL STATE & LOCAL BUILDING PERMITS WILL BE OBTAINED BY

OWNER & BE POSTED AT JOB SITE BY THE CONTRACTOR, U.N.O. ALL CONTRACT DOCUMENTS FOR THEIR ACCURACY AND CONFIRMING THAT WORK IS BUILDABLE AS SHOWN BEFORE PROCEEDING WITH CONSTRUCTION. IF THERE ARE ANY QUESTIONS REGARDING THESE, OR OTHER COORDINATION QUESTIONS, THE CONTRACTOR IS RESPONSIBLE FOR OBTAINING

6. THE OWNER SHALL INDEMNIFY AND HOLD HARMLESS THE DESIGN PROFESSIONAL FROM ANY CLAIM OR SUIT WHATSOEVER ARISING FROM, OR ALLEGED TO HAVE ARISEN FROM, THE CONTRACTOR'S PERFORMANCE OR THE FAILURE OF THE CONTRACTOR'S WORK TO CONFORM TO THE DESIGN INTENT OF

7. THE WORK UNDER THE CONTRACT SHALL INCLUDE ALL LABOR, MATERIALS, TOOLS, FEES, INSURANCE, TAXES, ETC. FOR

AND ELECTRICAL CONSTRUCTION, AS APPLICABLE, FOR THE COMPLETE CONSTRUCTION OF THIS PROJECT. 8. ALL PRODUCTS AND MANUFACTURERS OF MATERIALS/FINISHES/ETC PER ARCHITECTURAL DRAWINGS OR SPECIFICATION. SUBSTITUTIONS OF EQUAL QUALITY AND PERFORMANCE PERMITTED AS APPROVED BY DESIGN

PROFESSIONAL IN CHARGE. 9. ALL MATERIALS, SUPPLIES, AND EQUIPMENT SHALL BE INSTALLED AS PER MANUF. SPECIFICATIONS AND AS PER LOCAL CODES AND REQUIREMENTS, LOCATED PER PLAN

10. THE CONTRACTOR MUST VERIFY ALL EXISTING CONDITIONS 11. THE DESIGN PROFESSIONAL WILL NOT HAVE CONTROL OVER. OR CHARGE OF, AND WILL NOT BE RESPONSIBLE FOR THE CONSTRUCTION MEANS, METHODS, SEQUENCE OR PROCEDURES

12. ALL PROPERTY LINES ARE ASSUMED UNI ESS A CERTIFIED SURVEY MAP HAS BEEN PROVIDED FOR THE PROPERTY. 13. ALL BUILDING SETBACKS ARE MEASURED FROM THE EAVE LINE OF THE BUILDING.

14. THE CONTRACTOR IS TO HAVE ALL THE UTILITY LINES VERIFIED BY THE APPROPRIATE UTILITY LOCATING SERVICE. THE CONTRACTOR SHALL BE RESPONSIBLE TO HAVE A LOCATE DONE PRIOR TO BREAKING OF GROUND

UTILITIES LOCATIONS SUCH AS WATER, SEWER, AND GAS. 16. ALL DAMAGE TO EXISTING DRIVEWAYS, ROADWAYS, STREETS CONCRETE SIDEWALKS, LAWNS, ETC. MUST BE RESTORED TO THE 17. PROVIDE A MINIMUM OF 2% DRAINAGE SLOPE AWAY FROM ENTIRE PERIMETER OF BUILDING FOR THE FIRST 20 FEET, U.N.O. SHORING & TEMPORARY SUPPORTS, FTC. THE GENERAL

CONTRACTOR IS RESPONSIBLE FOR THE STABILITY OF THE STRUCTURE PRIOR TO THE APPLICATION OF ALL SHEAR WALLS,

OR FLUSH WITH ADJOINING MATERIALS. WORK OF EACH TRADE SHALL MEET ALL NATIONAL STANDARDS PUBLISHED BY THAT TRADE, EXCEPT IN THE CASE WHERE THE CONTRACT DOCUMENTS

20. ALL EXISTING BUILDING DIMENSIONS MUST BE FIELD

21. WRITTEN DIMENSIONS TO PREVAIL OVER SCALING OF DRAWINGS. CONTRACTOR(S) TO VERIFY ALL DIMENSIONS PRIOR TO CONSTRUCTION AND IMMEDIATELY NOTIFY DESIGNER OF ANY DISCREPANCIES. 22. ALL DIMENSIONS TO FACE OF STUD OR CONCRETE WALLS,

23. SEE SITE PLAN FOR NOTES AND DIMENSIONS NOT SHOWN. 24. SEE ELEVATIONS, INTERIOR ELEVATIONS AND FINISH

SCHEDULE FOR MATERIALS NOT CALLED OUT. 25. IF APPLICABLE, THE FIRE RATING OF WALLS AND CEILINGS MUST BE MAINTAINED BEHIND ALL INSTALLED FIXTURES (BATH UNITS, VANITIES, CEILING FANS, ELECTRICAL BOXES, EXHAUST

FANS, ETC. 26. THE CONTRACTOR SHALL TAKE ABSOLUTE CARE TO PROTECT NEWLY INSTALLED MATERIALS, MILLWORK, BUILT-INS & FINISHES. 27. THE CONTRACTOR SHALL PROVIDE ALL OPERATING AND MAINTENANCE DATA AND ALL MANUFACTURER'S, INSTALLER'S AND APPLICATOR'S GUARANTEES, BONDS, WARRANTIES AND

SERVICE INSTRUCTIONS. 28. CONFIRM WINDOW OR DOOR NUMBER WITH MFR. AND SITE CONDITIONS. ALL OPERABLE WINDOWS AND DOORS SHALL HAVE

29. CONTRACTOR TO VERIFY R.O. REQUIREMENTS FOR WINDOWS & EXTERIOR DOORS WITH WINDOW MANUFACTURER PRIOR TO 30. REFERENCE ELEVATIONS AND/OR BUILDING SECTIONS FOR

WINDOW OPERATIONS. 31. REFER TO ENGINEERED TRUSS DRAWINGS, IF APPLICABLE, FOR PLACEMENT OF TRUSS COMPONENTS. CONTRACTOR IS TO FIELD VERIFY ALL TRUSS DIMENSIONS BEFORE PRODUCTION OF

32. ALL GAS PIPING INSTALLATIONS SHALL COMPLY WITH NFPA

SQUARE FOOT(AGE)

STAINLESS STEEL

WITH

WOOD

WITHOUT

54-2015, NATIONAL FUEL GAS CODE.

INDEX TO DRAWINGS

ATS TITLE SHEET


C100 SITE PLAN.

A100 FLOOR PLAN A101 FLOOR PLAN - AREA BREAKDOWN

ERING

C.R. **AS NOTED** 05-24-22

22-3673

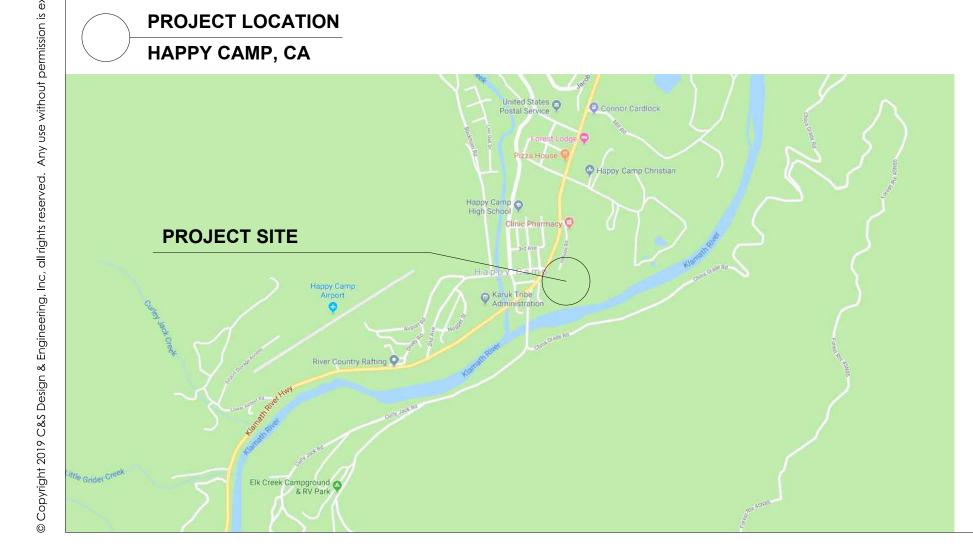


STANDARD ABBREVIATIONS ABOVE FINISH FLOOR CONTR. FIRE EXTINGUISHER OVERFLOW DRAIN ACT. ACOUSTICAL CEILING TILE F.E.C. CONTROL JOINT FIRE EXTINGUISHER CABINET JOINT STOR. COURSES CUBIC FOOT(AGE) FIXTURE STRUCT. ALIGN WITH BELOW A.W.B. FLASHING FLASH'G LAMINATED SUSPEND (ED) SUSP. (D) DETAIL PARTITION LAVATORY AI TERNATE FI OOR PERFORATED TELEPHONE ALUMINUM ALUM. DIAMETER FLOORING FLR'G LEVEL AMERICAN DISABILITIES ACT TPO ADA DIMENSION FLOOR PLAN LIGHTING PLASTIC LAMINATE THERMOPLASTIC POLYOLEFIN APPROX. LINOLEUM POLYVINYL CHLORIDE **FOUNDATION BASEMENT** DOWN LONG LEG HORIZONTAL POUNDS PER SQUARE INCH T.O.C. T.O.F. T.O.R. T.O.S. FLUORESCENT FLUOR TOP OF CONCRETE PRESERVATIVE TREATED TOP OF FOOTING BFAM DOWNSPOUT LONG LEG VERTICAL GALVANIZED BFI OW DRAWING (S DWG. (S) LOW POINT PROPERTY TOP OF RAIL BITUMINOUS DRINKING FOUNTAIN T.O.W. TOP OF WALL BLKG. BLOCKING GLASS MASONRY QUARRY TILE TREAD ELECTRICAL GYPSUM MASONRY OPENING TREATED BOARD RADIUS BOTTOM ELEVATION GYPSUM WALLBOARD MATERIAL TRENCH DRAIN MAX. BOTTOM OF ELEVATOR MAXIMUM REINFORCING TYPICAL ENCLOSURE HANDICAP ACCESSIBLE MECHANICAL REQUIRED RESILIENT FLOORING UNDERWRITERS EQUAL HARDWARE HDW. MEMBRANE EQUIP. EXH. BUILT-UP ROOFING EQUIPMENT HEATER RETURN AIR LABORATORIES METAL HEATING, VENTING, AND UNLESS NOTED OTHERWISE FXHAUST HVAC MINIMUM REVISION U.N.O. EXISTING EXIST. **MISCELLANEOUS** MISC AIR CONDITIONING RISER VENEER PLASTER C.I.P. CAST-IN-PLACE EXPANSION MOUNTED ROOF DRAIN EXPANSION JOINT NON-COMBUSTIBLE HOLLOW CORE CATCH BASIN EXPOSED NOT APPLICABLE **ROUGH OPENING** VERTICAL EXTERIOR NOT IN CONTRACT N.I.C. VINYL COMPOSITION TILE VCT. HOLLOW META CEILING RUBBER HORIZONTAL NOT TO SCALE N.T.S. VINYL WALL COVERING CEMENT HORIZ. VWC. FACE OF SECTION CENTER LINE HOUR NUMBER **CERAMIC TILE** FACE OF CONCRETE F.O.C. WATER CLOSET CLEARANCE FACE OF FINISH INCANDESCENT OCCUPANT / OCCUPANCY WATERPROOFING CLOSET FACE OF MASONRY F.O.M. ON CENTER SOLID CORE WELDED WIRE FABRIC W.W.F. W.F. INCLUDING **SPECIFICATIONS** COLUMN FFFT INCL OPENING WIDE FLANGE WDW. CONCRETE INSIDE DIAMETER OPPOSITE SQUARE WINDOW

OPPOSITE HAND

OUTSIDE DIAMETER

F.F.E.

INSULATION

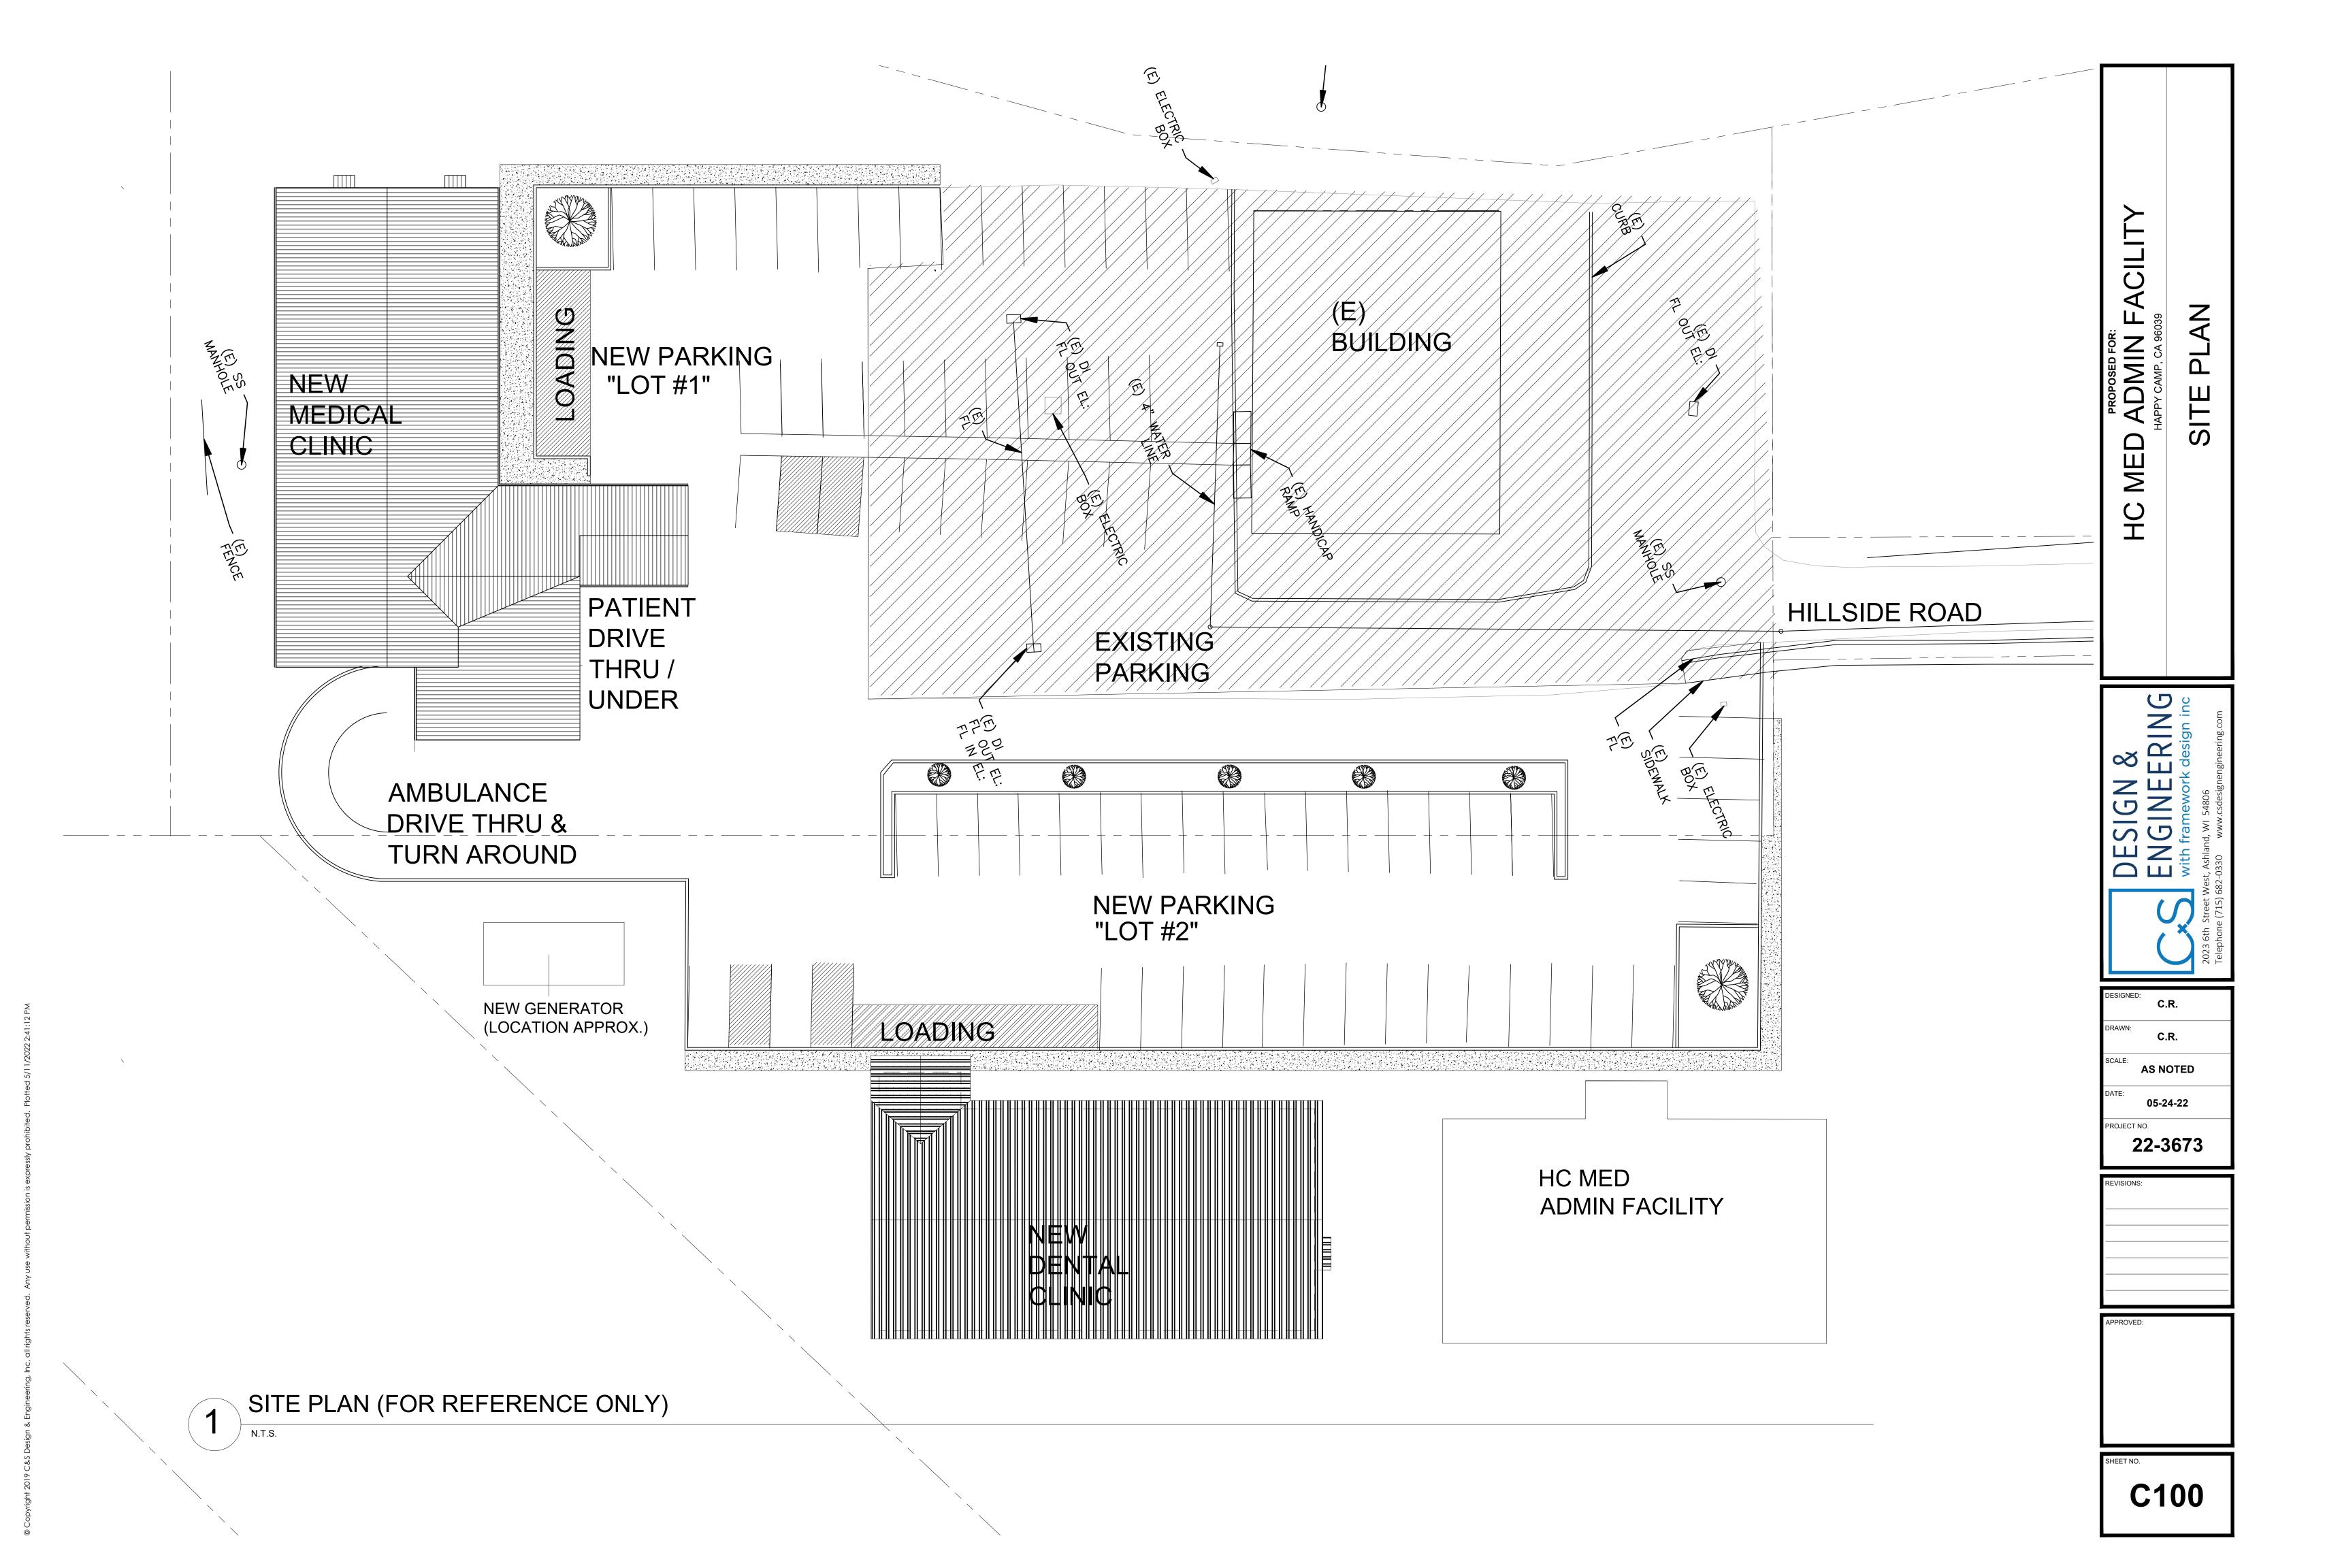

22-3673REVISIONS:

APPROVE

A100

1 FLOOR PLAN
3/16"=1'-0"

y, inc., airtignis teservea. Arry use wirrout permission is expressiy prombhea. Fromed 3/11/2022 2.41.12 FM



HC MED ADMIN FACILITY

HAPPY CAMP, CA 96039

OOR PLAN - AREA BREAKOUT

DESIGN &

PESIGN &

Note (715) 682-0330 www.cedesignengineering.com

DESIGNED:
C.R.

DRAWN:
C.R.

SCALE:
AS NOTED

DATE:
05-24-22

PROJECT NO.

22-3673

REVISIONS:

APPROVE

A101